



GATE AND GUARD HOUSE PLAN

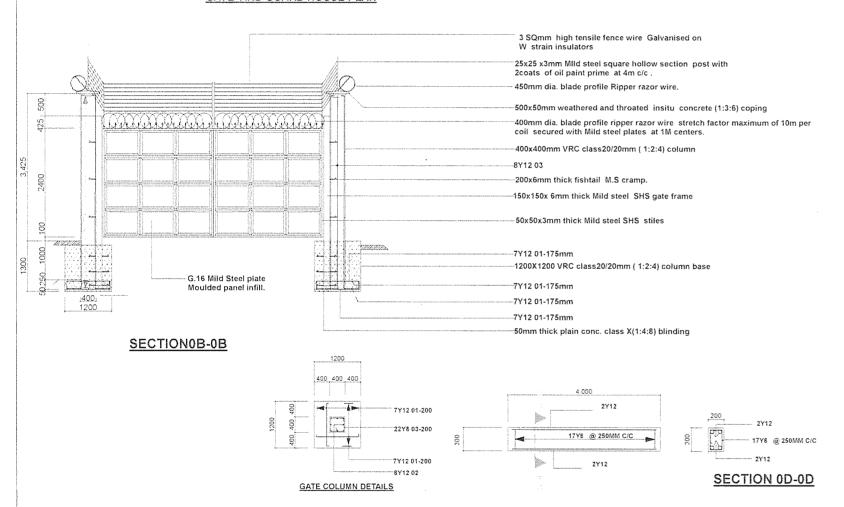

BEAM DETAILS

NAME DATE SIGN REF DATE APPROVED BY SIGN CHECKED DATE SOLOMON WERE APPROVED BY CHEROES 1/15 Deco-CONFIRMED BY RUTH OYILE THOMAS MOGO CHECKED BY S) S AUBMAW TAHPROL DRAWN BY

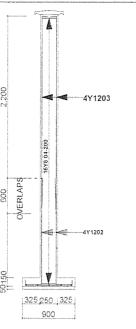

SECTION OC-OC

INTERMEDIATE COLUMN DETAILS

50mm thick plain conc(1:3:6) Cast Insitu copping 200mm machine cut stone wall on c.s.(1:3)mortal -250 x250mm VRC (1:2:4) 20mm thick Agg. columns at 4m C/C 300x200mm VRC (1:2:6) 20 thick agg. beam G.L -150mm th. RC (1:2:4) strip foundation on 50mm thick blindin -3Y1006-250 -300 x300mm VRC (1:2:4) 20mm thick Agg. columns at 4m C/C . -150mm VRC (1:2:4) 20mm thick Agg, columns base on 50mm thick plain conc.(1:4:8)blinding at 4m C/C. 600 900

WALL COLUMN DETAILS

NOTES

All dimensions are in mm unless otherwise specified.
Drawing are not to scalled, only figured dimensions to be used

The confractor must check and verify all demensions before commencement of any work. Depth of foundation to be determined on site to S.E 's aproval before placing of the concrete Foundation walls to be of 200mm thick fairly chisel dressed quarry blue stone or its equivalent on

-All supperstructure walls to be of 200mm thick machine dressed quarry stone on c/s (1:3) mortar - All intermediate columns to be of size 250x250 mm - VRC class 20/20mm (1:2:4) at 4 m centers, construction joints in 12mm thick flexel expansion and 25x25mm expansion sealer at every 20m in

All adjacent R.C. work and masonry walls to be tied with hoop iron at every alternate course.

All openings to have Permanent Ventilations
All soil under slab around and under foundation to be poisoned for termite control

All adjacent R.C. work and masonry walls to be tied with hoop iron at every alternate course. All gates to be of G.16 Mild steel overall size 6000x 2100mm (LxH) anchored to V. R. C. (1.2.4).

Minimum cover to main bars:

a. Bases and strip foundation - 50mm b. Cullumns & Beams - 25mm

c. Slab - 20mm Strike formwork as follows

Bases sides - 48Hrs Culumns & Beam sides - 48Hrs

Beam sofits - 28days All Reinforced concrete to be class 20/20mm

- Norminal mix 1:2:4

- machine mixed and vibrated

ELECTRIC FENCE

All electric fence to comprise 8 strads of hing tensile galvanizes fence wire spaced 100mm centers above the walling

All electric fence to comprise. Mains energizer EZ 640 or equal and approved battery and any other necessary accessories.

All electrical wiring to in PVC conduite consealed into the stone wall. block work on on cable trench. All cable trenches to be 750mm deep below ground level.

All doors and windows to have parmanent ventilations(PV). All floor finishes to be 40mm thick polished terrazzo unless otherwise

All perimeter wall surfaces to have 20mm deep keypointing horizontal and flush perpends on cement sand (1:2)mortar.

All external beam surfaces to have 15mm thick, 1 No. coatwork of cement and sand (1:3) render

All column along the road to be stonepitched with clay bricks on cement sand (1:3)mortar and 20mm

All internal wall surfaces at the guard houses to 2 coats of cement sand (1:3)plaster finished smooth

GATE SCHEDULE

No.	Code	Gate Description	Qty
Q1	D1	Mild steel Double leave side hinged gate size 6000x2400mm including pedestrian door size 900x1900mm .	03

PROPOSED RUIRU GO-DOWN PERIMETER WALL

GATE HOUSE PLAN, GATE DETAILS, SECTIONS, WALL DETAILS AND COLUMN DETAILS


Scale: 1:75 & 1:50



KENYA POWER

SHEET NO. 03

Kenya Power

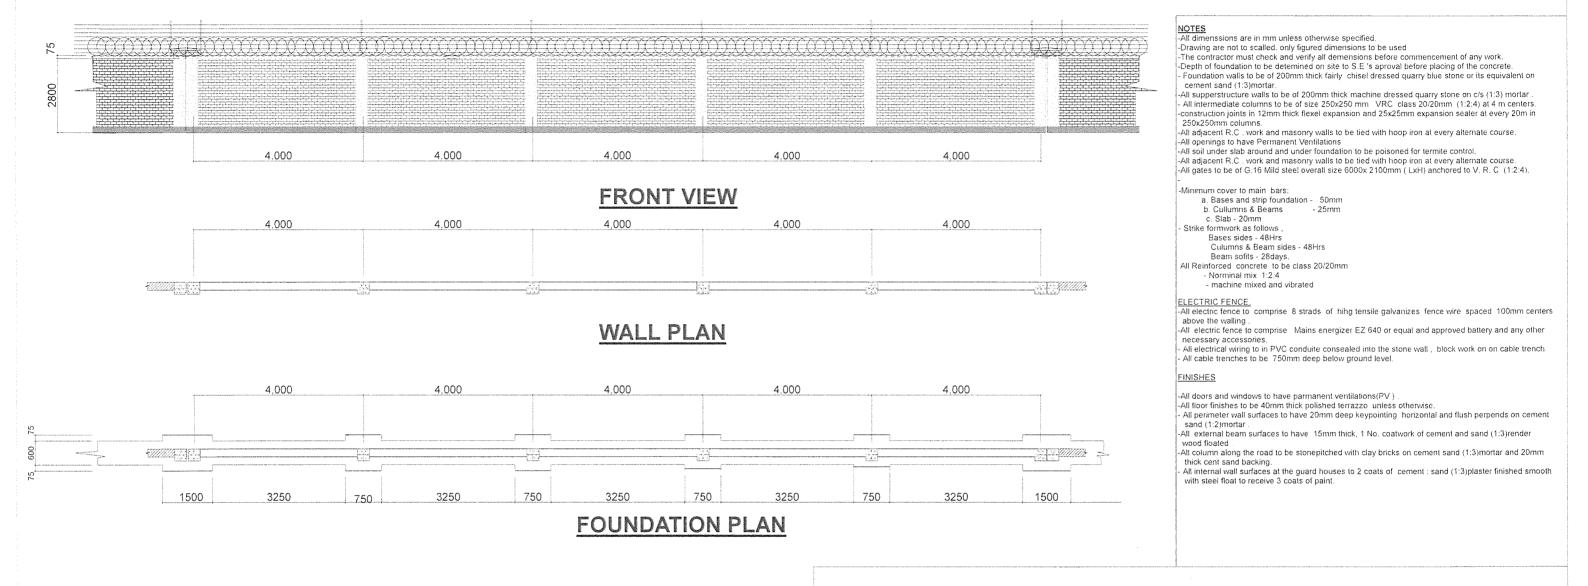

APPROVED BY	NAME	DATE	SIGN	REF	DATE	SIGN	OTTEORED	DATE
APPROVED BY	solomon were					and the continues of th		West fried and the finding of the fi
CONFIRMED BY	1	801/18	KECCO-	1.1		4		
CHECKED BY	THOMAS MOGOI	8/11/2018	15					
	JOSPHAT WAMBUA	-240 '	eliji8					

PROPOSED RUIRU GO-DOWN PERIMETER WALL

ELEVATION, WALL PLAN AND FOUNDATION PLAN

<u>Scale: 1:100</u>



KENYA POWER

SHEET NO-02

Kenya Power